

NATIONAL SENIOR CERTIFICATE

GRADE 12

ENGINEERING GRAPHICS AND DESIGN P1 EXEMPLAR 2008

MARKS: 100

TIME: 3 hours

This question paper consists of 6 pages.

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INSTRUCTIONS AND INFORMATION

- 1. The question paper consists of FOUR questions.
- 2. Answer ALL the questions.
- 3. All drawings are in first-angle orthographic projection unless otherwise stated.
- 4. All drawings must be drawn to scale 1:1, unless otherwise stated.
- 5. The questions must be answered on the answer sheets provided.
- 6. All the answer sheets must be re-stapled in numerical sequence and handed in irrespective of whether the question was attempted or not.
- 7. Careful time management is essential in order to complete all the questions.
- 8. Print your examination number in the block provided on every answer sheet.
- 9. All answers must be drawn accurately and neatly.
- 10. Any details or dimensions not given must be assumed in good proportion.

FOR OFFICIAL USE ONLY								
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QUESTION 1: ANALYTICAL (CIVIL)

DoE/Exemplar 2008

Given:A table of questions and a site plan of a proposed new dwelling.

Instructions:

Complete the table below by neatly printing the answers to the questions, which all refer to the accompanying drawing.

[25]

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15000 TSHEDZA STREET 4 (N) (၁) (ω) <u>1</u> 3 3 17 16 15 12 6 19 0 5 9 ∞ 4 ω 2 \mid What is the distance between the proposed dwelling and the dwelling on erf number 58? What is the feature at 6 called? What is the feature at 2 called? What is the feature at 1 called? What is the erf number of the proposed dwelling? What is the total length of the dwelling in metres? What is the distance from the boundary line to the building line at the back of the property? What is the feature at 5 called? What is the feature at 4 called? What is the feature at 3 called? What do the the letters RE stand for? What is the scale of the drawing? What is the total area of the site in m²? The side of the house that faces the road will be called the What do the letters IE stand for? What is the width of the street in metres? What colour must a proposed new dwelling be on a site plan? What is on the property behind the proposed dwelling? What is the erf number of the adjacent property on the south side? What is the name of the street? QUESTIONS elevation? **ANSWERS TOTAL 25**

OPEN SPACE

4000

4000

ERF 54

25000

30000

4000 9000 $\overline{\mathbb{m}}$ 8000 PROPOSED NEW DWELLING ERF 58 5000 4000 SITE PLAN SCALE 1:200 5000 (တ

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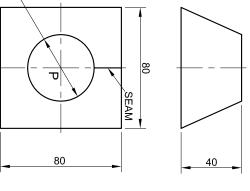


QUESTION 2: DEVELOPMENT

Given:The front view and top view of a square to round transition piece.

- Instructions:Draw the given views of the transition piece.Develop the surface of the transition piece.Show ALL necessary construction and fold lines.

[35]



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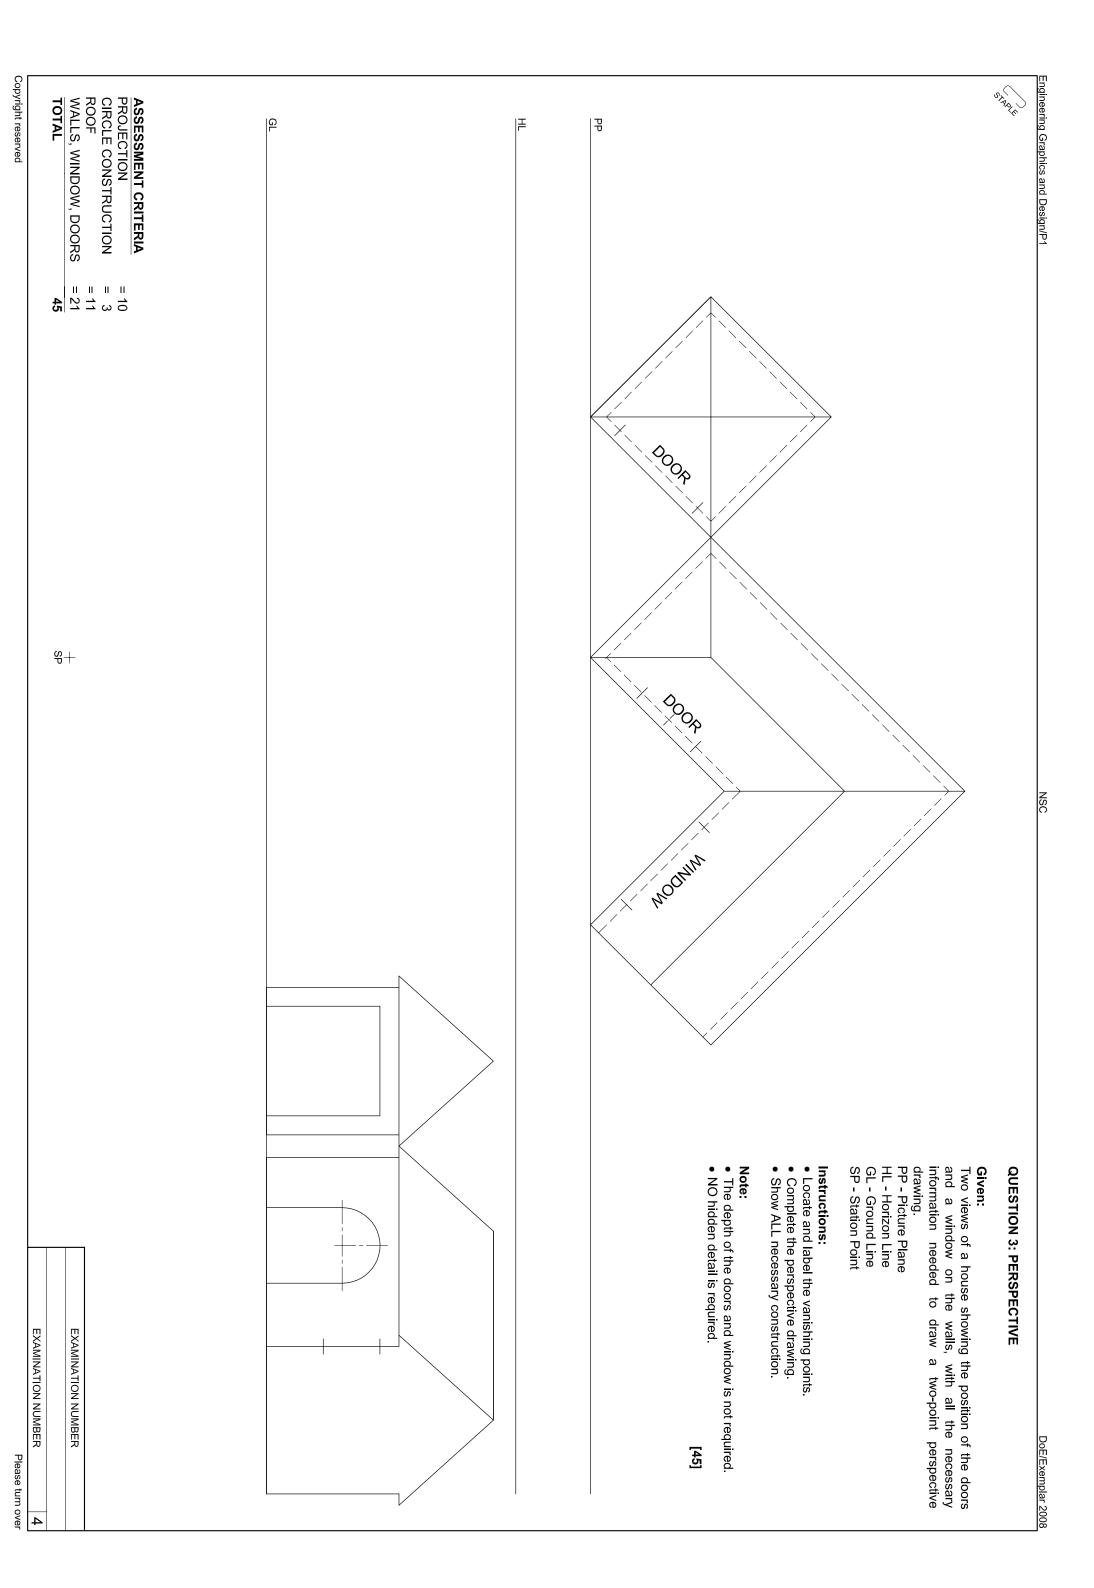
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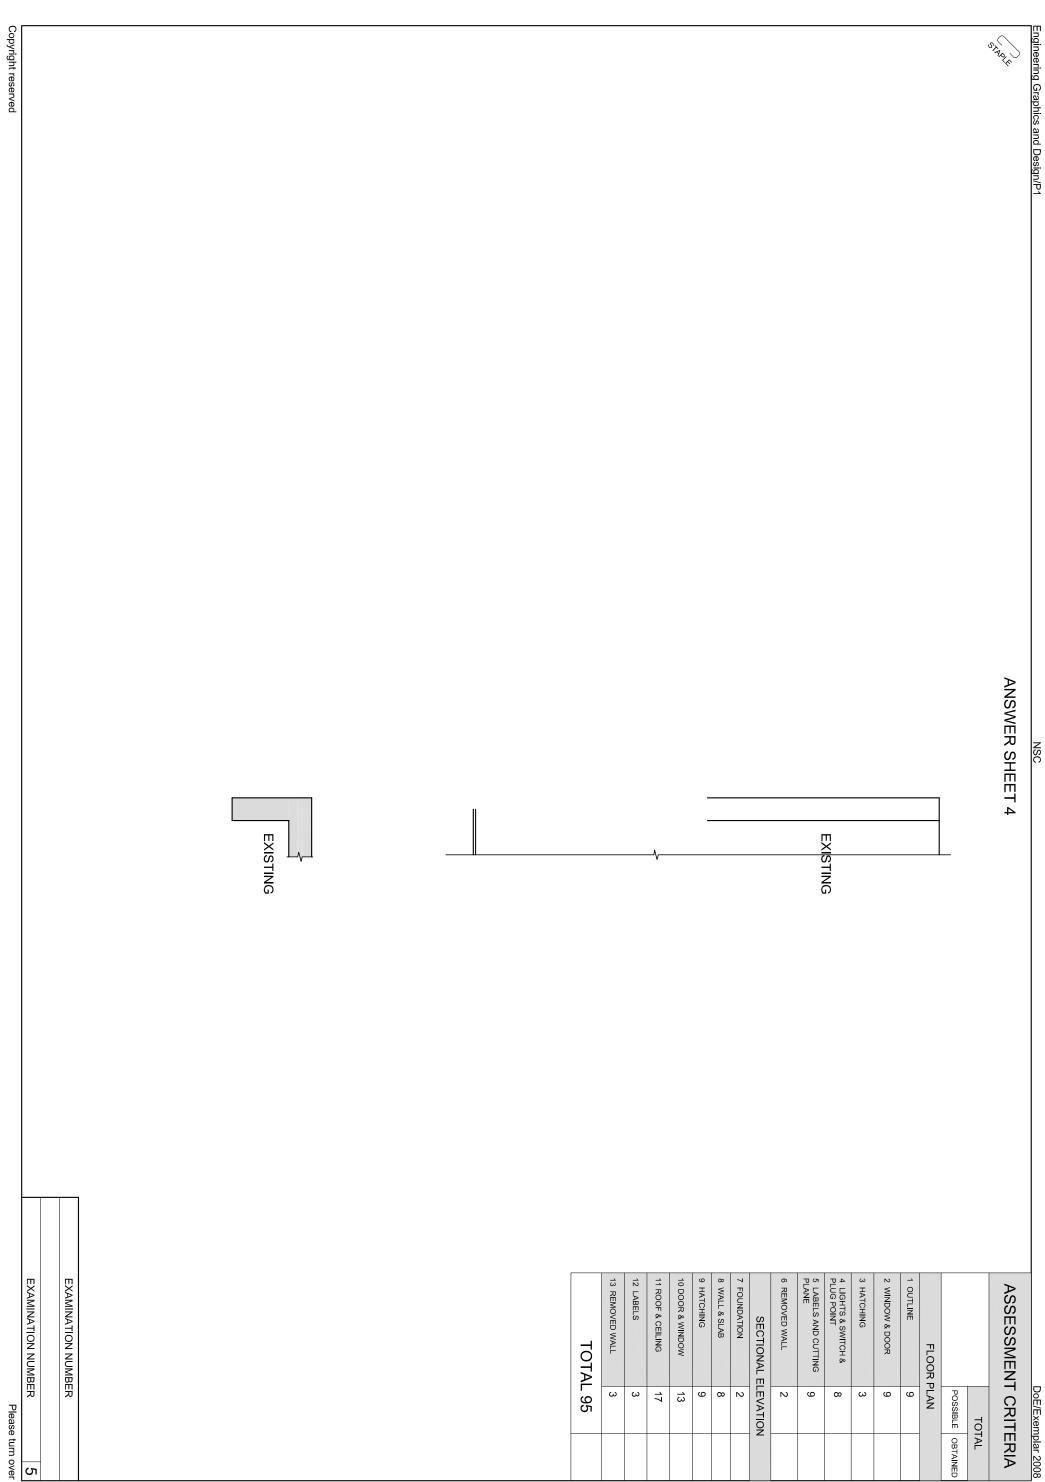
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EXAMINATION NUMBER

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ASSESSMENT CRITERIA
FRONT VIEW
TOP VIEW
CIRCLE DIVISION
TRUE LENGTH x2
DEVELOPMENT
CENTRE LINES
TOTAL





STADIK

WINDOW SCHEDULE DOOR SCHEDULE AND

DOOR FRAME STANDARD, EXTERNAL, MILD STEEL PROPOSED NEW LAUNDRY ON STAND 354 PHOENIX MR K NAIDOO DRAWING NUMBER DOE 1-08 WINDOW STANDARD, MILD STEEL, ND 2

7 ZIBI ROAD DURBAN 031 708 5555

4000

FRAME PROFILE 46 [4] 32


DOOR H/W FRAMED, LEDGED AND BATTENED


TWO-LEVER LOCKSET RONMONGERY PAIR 75 mm BOLTS,


GLAZING 3 mm CLEAR GLASS


242


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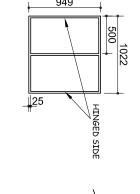


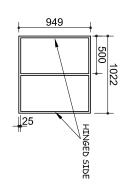


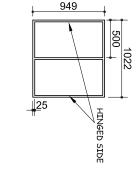


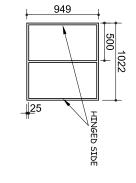

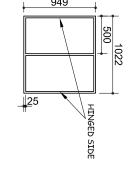

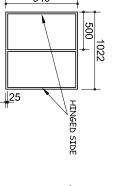

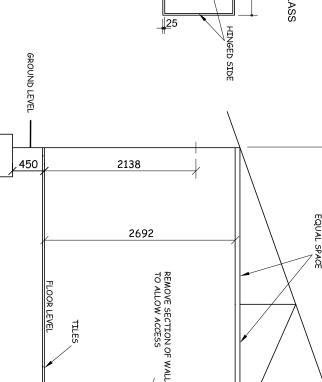

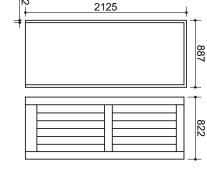

ELECTRICAL LEGEND

OR X


2 X 40 W

SOCKET OUTLET

D


D-

OR X

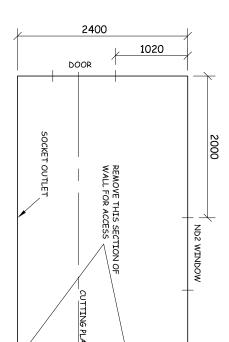



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INCOMPLETE FOUNDATION DETAIL

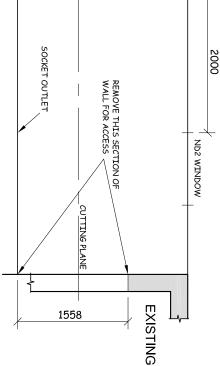- A schematic floor plan and schematic elevation showing the outer perimeter of a proposed new laundry to an existing dwelling detailing the positions of all the features.
- A door and incomplete window schedule.
- Sketches of the roof and incomplete foundation detail.
- An electrical legend.

Instructions:

- Answer this question on ANSWER SHEET 4 on page 5.
- Draw, to scale 1:40, the complete floor plan and complete sectional elevation to the given specifications.
- ANSWER SHEET 4. Attach the drawings of the proposed new laundry to the given information on

EXISTING

Specifications: THE FLOOR PLAN

- Add the following features to the floor plan:
- ALL the walls with hatching detail
- The door and the window detail
- The removed section of the wall of the existing dwelling
 ONE light outside the door and a single TWO, 40 watt fluorescent tube fitting in the centre of the ceiling of the laundry
- ONE switch for both lights

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- ONE switched socket outlet in the middle of the indicated wall
- The cutting plane. Label the plane
- Label the floor plan and include the scale


THE SECTIONAL ELEVATION


Add the following features to the sectional elevation:

- The complete foundation, wall, floor slab and roof detail
- The door and complete window det
- The removed section of the wall of the existing dwelling
- ALL necessary hatching
- Label the sectional elevation: SECT FIONAL ELEVATION ON A-A

- Label ONLY the following features course, window code, room design on the correct view: natural ground level, damp proof ation and floor finish.
- ALL drawing must comply with the guidelines contained in the SABS 0143.

[95]

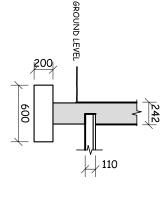

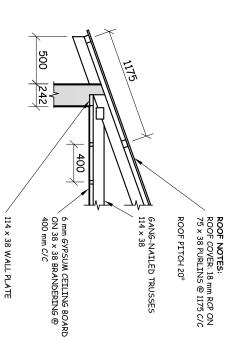

INCOMPLETE ROOF DETAIL